Section 57(3) Land Use Planning Approvals Act 1993
An application for a planning permit has been made which may affect you.

APPLICATION FOR PLANNING PERMIT

Application Details

Application Number: PA2024.0047

Proposed Use or Development: Residential (single dwelling)

Address of the Land: 363 Melrose Road, Eugenana

Date of Notice: **04/05/2024**

You are invited to view the application and any documents and plans accompanying it on the ground floor of the paranaple centre at 137 Rooke Street, Devonport or on Council's website www.devonport.tas.gov.au

Any person may make a representation relating to the application in accordance with section 57(5) of the Land Use Planning Approvals Act 1993, during a period of 14 days commencing on the date of this notice.

Your representation must:

- be received by close of business on 17/05/2024;
- be in writing; and
- addressed to the General Manager, Devonport City Council:
 - o P.O. Box 604, Devonport, Tasmania, 7310; or
 - o council@devonport.tas.gov.au

If you make a representation then Council must consider your submission before making its decision on the application.



Devonport City Council
PA2024.0047 - 363 Melrose Road, Eugenana

This map is made available for the purpose of providing access to Devonport City Council information and not as professional advice. The information contained on the map is diagrammatic only. All information should be verified on site, or with the appropriate State Government Department or Council Office, prior to being used for any purpose.



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Devonport City Council



Proposed single dwelling

363 Melrose Road EUGENANA

April 2024

Job Number: L240423

Prepared by: Michelle Schleiger (michelle@woolcottsurveys.com.au)

Town Planner

29 April 2024 Review

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1. Introduction

1.1 Application

This report has been prepared in support of a planning permit application under Section 57 of the *Land Use Planning and Approval Act 1993* (the 'Act').

This application is to be read in conjunction with the following supporting documentation:

Document	Consultant
Building design	Tasbuilt Homes/Engineering Plus

1.2 Application Summary

The following is a summary of the application information:

Address	363 Melrose Road, Eugenana TAS 7310
Property ID	1857460
Title	129629/2
Land area	7727ha
Proposed development	Single dwelling
Planning Authority	Devonport Council
Easements/Agreements	Pipeline easement
Zone	Rural Living Zone A
General Overlays	None
Code Overlays	Bushfire Prone Areas

1.3 The Proposal

The proposal is to develop the land with a single dwelling. The proposed dwelling will have a building area of 155.4m² and will have three bedrooms; kitchen, living area, bathroom, ensuite and laundry. The dwelling will have a decked area of 44.61m² on the north elevation.

The site has an existing outbuilding.

The development will have onsite stormwater and wastewater management. The plans provided at Annexure 2 provide further detail.



Figure 1 – Aerial view of subject site (Source: LISTMap).

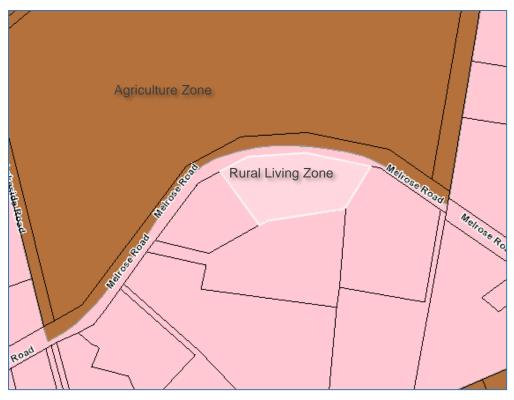


Figure 2 - Zoning of the subject site (Source: LISTMap)

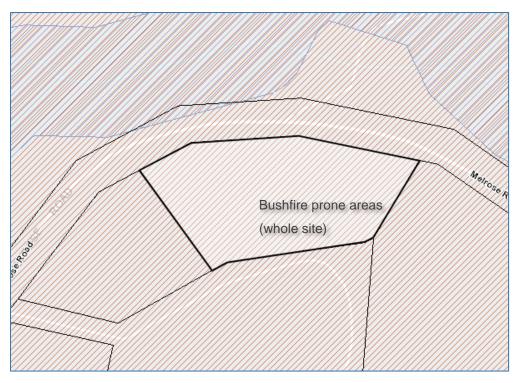


Figure 3 - Overlays affecting the subject site (Source: LISTMap)

2. **Planning Assessment**

2.1 Planning Scheme Zone Assessment

11.0 Rural Living Zone

11.4 Development Standards for Buildings and Works

11.4.1 Site coverage

Response

Α1 The acceptable solution is achieved. The site coverage equates to 326.4m² for the proposed dwelling and outbuilding.

11.4.2 Building height, setback and siting

Response

- Α1 The acceptable solution is achieved. The building height is maximum 4.3m
- Α2 The acceptable solution is achieved. The setback to the frontage is minimum 41m.
- А3 The acceptable solution is achieved. The side boundary setback is minimum 11m.
- Ρ4 The performance criteria are addressed. The building cannot achieve a distance of 200m from the Agriculture Zone as the subject site is not dimensioned to allow this.
 - a. The site is irregular in shape and has an area of 7727m². The lot is elevated from the road, and has vertical distance to farming activity (grazing).
 - b. The proposed is similar to surrounding development in terms of separation.

- The adjoining properties are developed with dwellings and are in the Rural Living Zone.
- d. No attenuation measures are proposed as the uses and activities are separated by a road. The farmed land has some vegetation buffering on the roadside

The Rural Living Zone is considered a transition zone from the three core residential zones to the rural zones, providing residential use and development on large lots in rural settings1.

The proposed is typical to the zone and sufficient separation is achieved in the context of the zones, surrounding use and expected activities. No interference or nuisances are anticipated.

2.2 Planning Scheme Code Assessment

C2.0 Parking and Sustainable Transport Code

C2.5Use Standards

C2.5.1 Car parking numbers

Table E6.1 Parking Space Requirements (extract)

Parking Requirements Use: Residential

Residential: Any Residential use in any other zone (RLZ)

One space per bedroom or two spaces per three bedrooms.

Response

Α1 The acceptable solution is achieved.

Two car parking spaces can be accommodated on the site.

C2.6 Development Standards for Buildings and Works

All access ways and parking is as existing with no further development proposed unless required for bushfire safety requirements.

3. Conclusion

The proposed development is for the development of a single dwelling in the Rural Living Zone. The development is compliant with the provisions of the Tasmanian Planning Scheme - Devonport and a permit for development is sought accordingly.

¹ Tasmanian Planning Scheme – Rural Living Areas; Fact Sheet 6


Annexure 1 – Copy of title plan and folio text


Annexure 2 – Proposal plan




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East Coast office
52 Cecilia Street
St Helens 7216
p (03) 6376 1972

Hobart South office Rear studio, 132 Davey Street Hobart 7000 p (03) 6227 7968

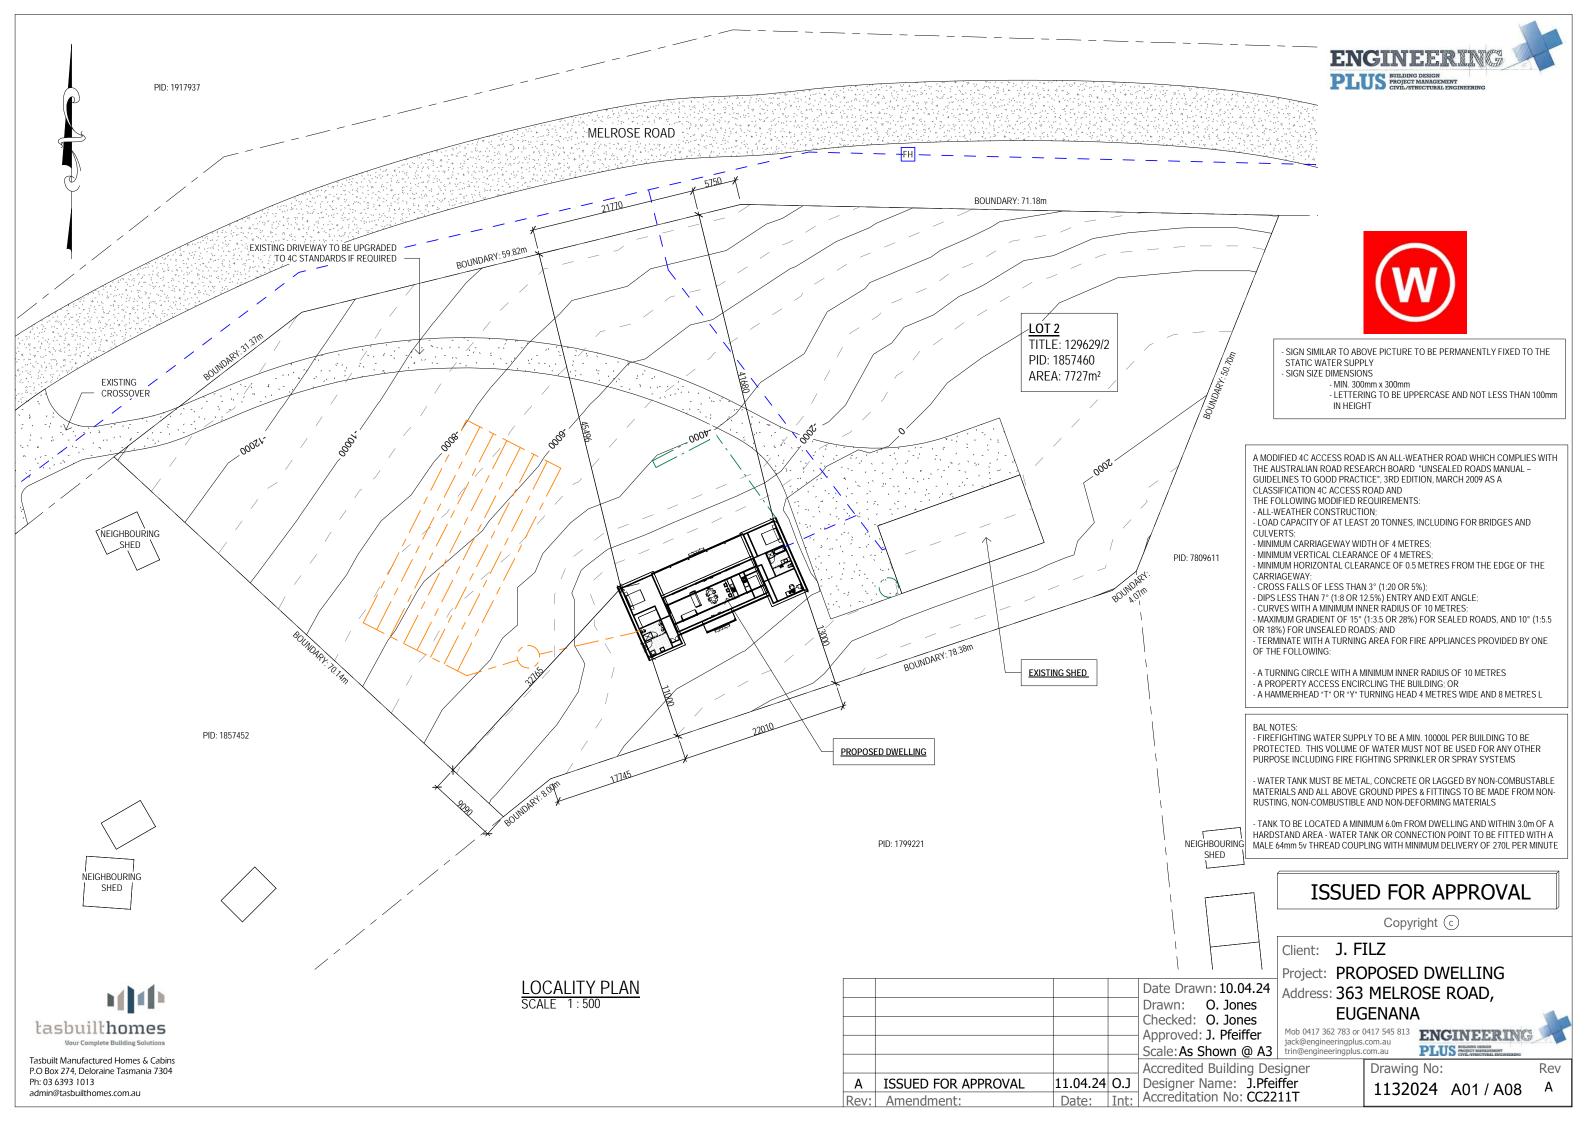

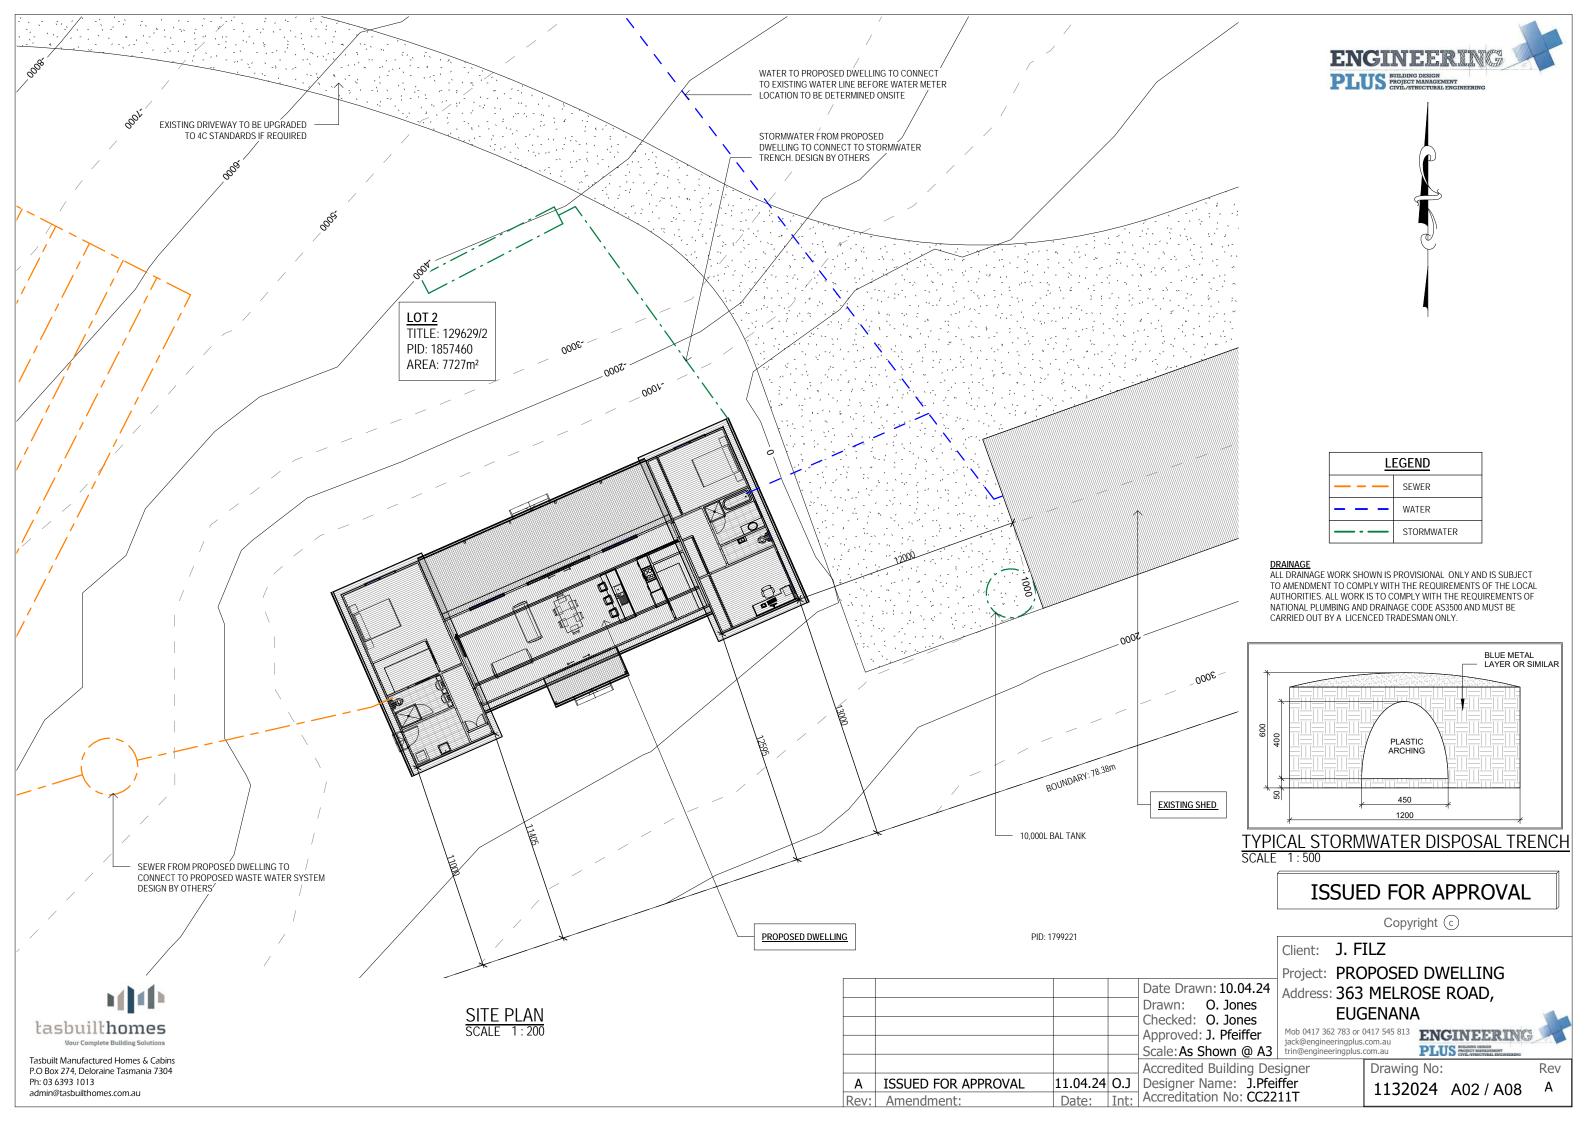



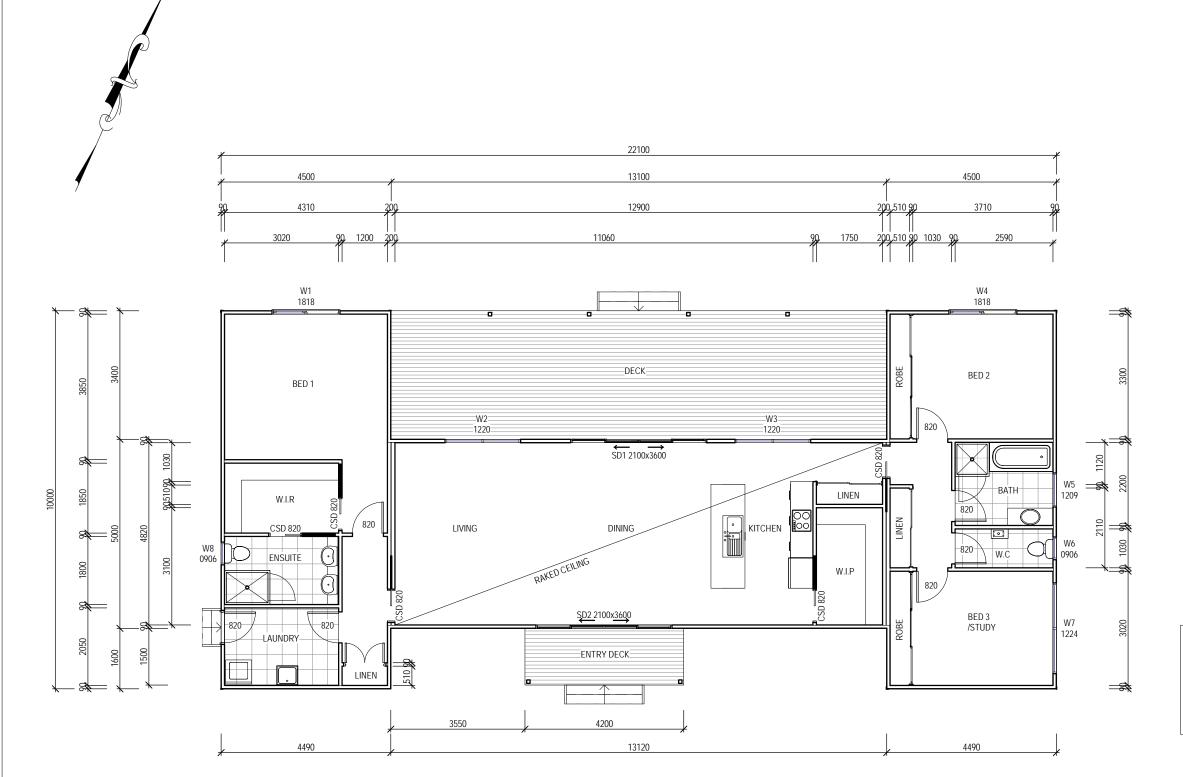

WINDOW SCHEDULE

MARK HEIGHT WIDTH TYPE U-VALUE SHGC

W1 W2 W3 W4 W5 W6 W7 W8 *W9 *W10	1800 1200 1200 1800 1200 900 1200 900 400 400 400	1800 2000 2000 1800 900 600 2400 600 2000 3600 2000	DG DG DG DG DG DG DG DG	4.3 4.3 4.3 4.3 4.3 4.3 4.3 4.3 4.3	.55 .55 .55 .55 .55 .55 .55 .55
SD1	2100	3600	DG	4.0	.61
SD2	2100	3600	DG	4.0	.61

*REFER ELEVATIONS FOR HIGHLIGHT WINDOW

DISCLAIMER:

ALL WINDOWS SHOWN ON PLAN ARE APPROX. BASED OFF STANDARD MANUFACTURING SIZES. ALL WINDOW DIMENSIONS TO BE CONFIRMED ON SITE BY BUILDER PRIOR TO ORDERING AND MANUFACTURING.

CONSTRUCTION PLAN SCALE 1:100

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Client: J. FILZ

Project: PROPOSED DWELLING Date Drawn: 10.04.24 Address: 363 MELROSE ROAD,

EUGENANA

Approved: J. Pfeiffer
Scale: As Shown @ A3

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jack@engineeringplus.com.au
trin@engineeringplus.com.au

Rev

Area Schedule (Gross Building) Name Area Area (sq) PROPOSED DWELLING 155.40 m² 16.73 DECK 44.61 m² 4.80 LANDING 6.30 m² 0.68 206.31 m² 22.21

					Date Drawn: 10.04.24
					Drawn: O. Jones
1					Checked: O. Jones
1					Approved: J. Pfeiffer
+					Scale: As Shown @ A3
+					Accredited Building De
	Α	ISSUED FOR APPROVAL	11.04.24		Designer Name: J.Pfe
	Rev:	Amendment:	Date:	Int:	Accreditation No: CC2

Accredited Building Designer Designer Name: J.Pfeiffer Accreditation No: CC2211T

Drawing No: 1132024 A03 / A08


P.O Box 274, Deloraine Tasmania 7304 Ph: 03 6393 1013

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Tasbuilt Manufactured Homes & Cabins





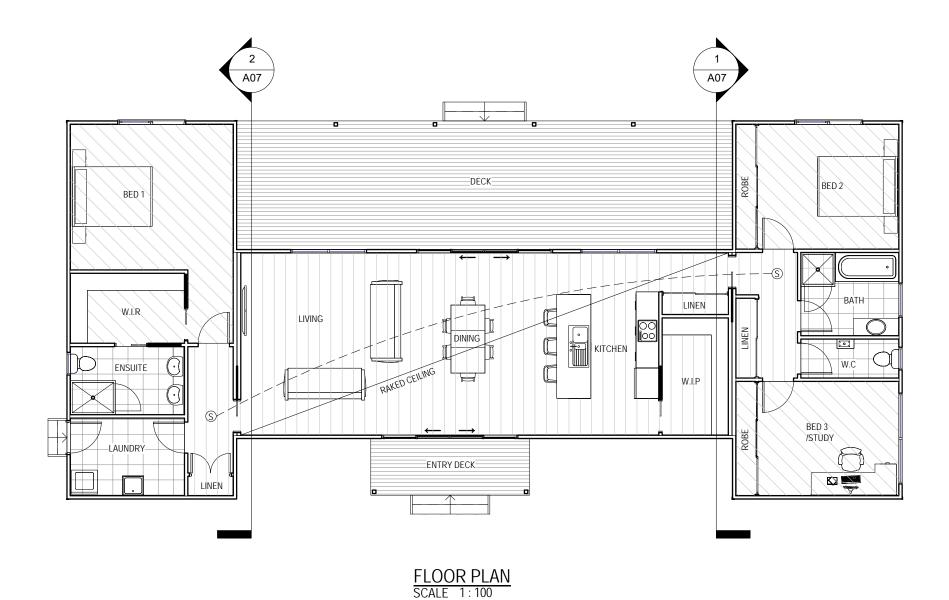

FLOOR COVERINGS CARPET CONCRETE TIMBER DECKING TILE VINYL TIMBER FLOORING

SMOKE ALARMS
PROVIDE AND INSTALL SMOKE ALARMS & HARD WIRE
TO BUILDING POWER SUPPLY TO AS 3786.
CEILING MOUNTED WITH 9VDC
ALKALINE BATTERY BACKUP
TO LOCATIONS INDICATED ON PLAN AND IN ACCORDANCE
WITH NCC PART H3D6 - ACBC PART 9.5

S - DENOTES INTERCONNECTED SMOKE DETECTORS

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Project: PROPOSED DWELLING Address: 363 MELROSE ROAD,

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Rev

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Drawing No: 1132024 A04 / A08



Tasbuilt Manufactured Homes & Cabins P.O Box 274, Deloraine Tasmania 7304 Ph: 03 6393 1013 admin@tasbuilthomes.com.au

Area Schedule (Gross Building)				
	Name	Area	Area (sq)	
	PROPOSED DWELLING	155.40 m²	16.73	
	DECK	44.61 m²	4.80	
	LANDING	6.30 m ²	0.68	

206.31 m²

					Date Drawn: 10.04.24	Addres
					Drawn: O. Jones	, , , , , , ,
					Checked: O. Jones	
-					Approved: J. Pfeiffer	Mob 0417 jack@eng
L					Scale: As Shown @ A3	trin@engi
					Accredited Building Des	signer
	Α	ISSUED FOR APPROVAL	11.04.24	O.J	Designer Name: J.Pfei	ffer
Ī	Rev:	Amendment:	Date:	Int:	Accreditation No: CC22	11T

SUB FLOOR VENTILATION. BCA Volume 2 PART 3.4.1.

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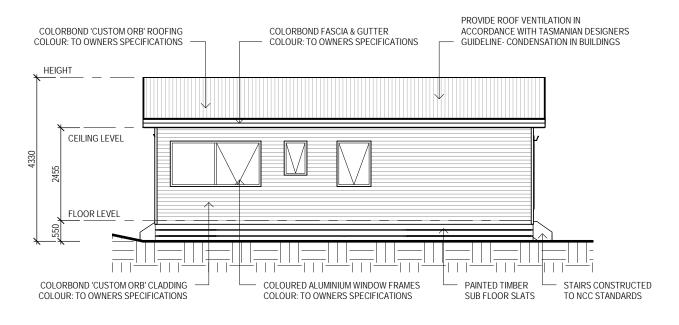
Ph: 03 6393 1013

- A MINIMUM OF 150 MM OF SUB FLOOR CLEARANCE IS TO BE PROVIDED BETWEEN FINISHED SURFACE LEVEL & THE UNDERSIDE OF THE FLOOR BEARER.
- A MINIMUM OF 6000 MM2 PER METRE OF SUB FLOOR VENTILATION IS TO BE UNIFORMLY DISTRIBUTED AROUND THE EXTERNAL AND INTERNAL WALLS OF THE BUILDING.
- VENTS TO BE LOCATED NO GREATER THAN 600 MM FROM AN INTERNAL OR EXTERNAL CORNER.


PRYDA 230x75 - 52 HOLE VENT MAXIMUM SPACING 1050 MM ALONG WALL OR PRYDA 230x165 - 117 HOLE VENT MAXIMUM SPACING 2350 MM ALONG WALL

ADDITIONAL VENTILATION PROVISIONS TO BE INSTALLED WHERE OBSTRUCTIONS SUCH AS CONCRETE VERANDAH'S, DECKS, PATIOS AND PAVING ARE INSTALLED & OBSTRUCT VENTILATION.





EAST ELEVATION SCALE 1:100

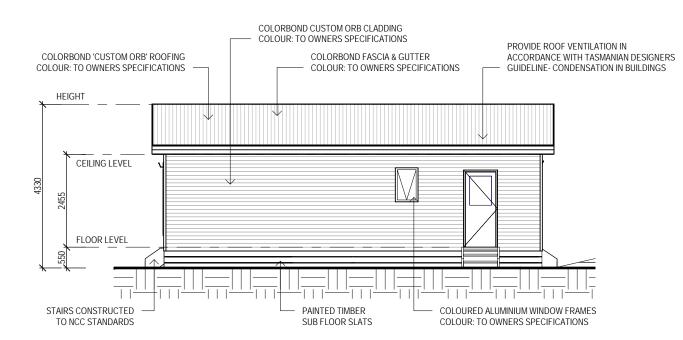

WEST ELEVATION SCALE 1:100

STAIR CONSTRUCTION. BCA VOLUME 2 PART 3.9

 TREADS: 240 MM RISERS: 180 MM

- TREATED PINE TIMBER STAIR MATERIAL TO ASI684
- TREATMENT LEVELS H4 FOR INGROUND USE & H3 FOR ABOVE GROUND USE.
- ALL FIXINGS FITTING BRACKETS AND CONNECTORS TO BE GALVANISED.
- STRINGER: 300x50 F5 TREATED PINE
- TREADS: 240x45 F5 TREATED PINE MAXIMUM TREAD SPAN 1000

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Client: J. FILZ Project: PROPOSED DWELLING

Address: 363 MELROSE ROAD,

EUGENANA

Mob 0417 362 783 or 0417 545 813 **ENGINEERING**

Rev

PLUS PROJECT MANAGEMENT

Drawing No:

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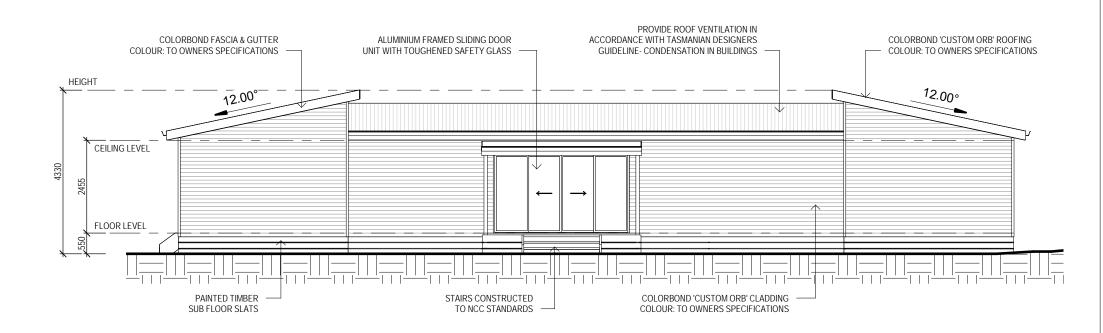
Date Drawn: 10.04.24 Drawn: O. Jones Checked: O. Jones Approved: J. Pfeiffer Scale: As Shown @ A3 | trin@engineeringplus.com.au

Accredited Building Designer 11.04.24 O.J Designer Name: J.Pfeiffer Date: Int: Accreditation No: CC2211T


1132024 A05 / A08

SOFFIT / EAVE LINED WITH 'HARDIFLEX' CEMENT SHEETING

- TRIMMERS LOCATED WITHIN 1200 MM OF EXTERNAL CORNERS TO BE SPACED @ 500 MM CENTERS, REMAINDER OF SHEET 700 MM CENTERS
- FASTENER / FIXINGS WITHIN 1200 MM OF EXTERNAL CORNERS @ 200 MM CENTERS, REMAINDER OF SHEET 300 MM CENTERS



SOUTH ELEVATION SCALE 1:100

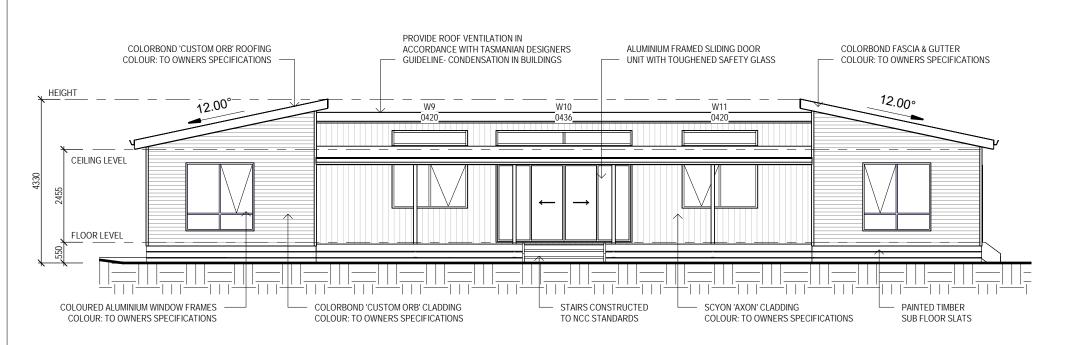

NORTH ELEVATION SCALE 1:100

SELECTED ALUMINIUM FRAMED WINDOWS - BCA VOLUME 2 PART 3.6

POWDER COATED ALUMINIUM WINDOW & DOOR FRAMES, UNLESS OTHERWISE NOTED.

TASMANIAN OAK REVEALS AND TRIMS. ALL FLASHING AND FIXINGS TO MANUFACTURERS SPECIFICATIONS.

GLAZING & FRAME CONSTRUCTION TO AS 2047 & AS 1288

ALL FIXINGS AND FLASHINGS TO MANUFACTURERS REQUIREMENTS

• WIND CLASSIFICATION AS4055 WIND DESIGN: N2 50M/s

TERRAIN CATEGORY: TI (NO SHIELDING)

SERVICEABILITY DESIGN & WIND PRESSURE: 1000

• WATER RESISTANCE: 150

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Date Drawn: 10.04.24
Drawn: O. Jones
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Approved: J. Pfeiffer
Scale: As Shown @ A3
Accredited Building Des

11.04.24 O.J Designer Name: J.Pfeiffer

Date: Int: Accreditation No: CC2211T

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Project: PROPOSED DWELLING Address: 363 MELROSE ROAD,

EUGENANA

jack@engineeringplus.com.au trin@engineeringplus.com.au

Client: J. FILZ



Rev

Drawing No:

1132024 A06 / A08

PROVIDE THERMAL INSULATION IN ACCORDANCE WITH THE FOLLOWING

R3.5 "ROCKWOOL" BULK INSULATION OR R3.5 GLASSWOOL BATTS BETWEEN CEILING JOISTS UNDER ROOF COMPOSITE FOIL & R1.5 BLANKET

'TYVEK' HOUSE WRAP (OR SIMILAR) TO EXTERNAL FACE R2.5 GLASSWOOL BATTS BETWEEN STUDS

SUB FLOOR

85mm R2.5 POLYSTYRENE BETWEEN JOISTS

NOTE: CERTIFICATE OF COMPLIANCE TO BE PROVIDED BY THE PERSON ENGAGED TO INSTALL INSULATION TO WALLS AND CEILING AND COPY OF SAME TO BE FORWARDED TO THE BUILDING SURVEYOR.

ALL TIMBER FRAMING GENERALLY IS TO COMPLY WITH THE REQUIREMENTS OF AS1684 [RESIDENTIAL TIMBER FRAMED CONSTRUCTION} & THE BCA CODE PART 3.4.3 WALL FRAMING TO BE MGP10 RADIATA PINE. COMMON STUDS - 90x35 @ 450 CRS. NOGGINGS - 90x35 OPEN STUDS - 90x35 TOP & BOTTOM PLATES - 90x35 BRACING TO AS 1684 & NCC CODE

<u>SLABS & FOOTINGS</u> ALL CONCRETE PREPARATION INCLUDING EXCAVATIONS & PLACEMENT OF REINFORCEMENT IS TO BE SEEN & APPROVED BY COUNCIL BUILDING INSPECTOR AND/OR ENGINEER PRIOR TO POURING ANY CONCRETE. REFER TO ENGINEERS DRAWINGS FOR FOOTING & CONCRETE SLAB DETAILS. REFER TO SOIL REPORT FOR CLASSIFICATION & SITE MAINTENANCE REQUIREMENTS.

EXTERNAL CLADDING

EXTERNAL WALL CLADDING REFER ELEVATIONS SUB FLOOR

REFER ELEVATIONS

COLOURED ALUMINIUM WINDOW FRAMES. AWNING & HORIZONTAL SLIDING SASHES, REVEALS AND TRIMS TO OWNERS SPECIFICATIONS ALL FIXINGS AND FLASHING TO MANUFACTURERS RECOMMENDATIONS REFER AS 1288 & CURRENT NCC STANDARDS.

LINE WALLS AND CEILINGS INTERNALLY WITH 10mm PLASTERBOARD SHEETING. SQUARE SET MOULDING TO CEILING JUNCTION WITH WALL. PLASTERBOARD LININGS TO WET AREAS TO BE "VILLABOARD", W.R. BOARD OR OTHER APPROVED WATERPROOF LINING

WATERPROOFING OF WET AREAS WITHIN THE DWELLING IE: SHOWERS, BATHROOMS WATERPROOFED IN ACCORDANCE WITH BCA PART 3.8.1.1 TO 3.8.1.27 INCLUSIVE AND FIG NOS 3.8.1.5 TO 3.8.1.16 INCLUSIVE. AND TABLE 3.8.1.1

EAVES

OVERHANG ROOFS 300mm WHERE ROOFS OVERHANG LINE WITH FLEX BOARD SHEETING IN ACCORDANCE WITH AS 1684.2 7.2.24

COLORBOND PREFORMED METAL FASCIA AND GUTTER INSTALLED IN ACCORDANCE WITH MANUFACTURERS INSTRUCTIONS. COLOUR TO OWNERS SPECIFICATIONS.

ROOF FRAMING

COLORBOND CUSTOM ORB, COLOUR TO OWNERS SPECIFICATIONS APPROVED ROOF TRUSSES INSTALLED STRICTLY IN ACCORDANCE WITH MANUFACTURERS RECOMMENDATIONS. ALL TRUSS FIXING DETAILS TO BE ADHERED TO. FIX TRUSSES TO TOP PLATES WITH TRIP-L-GRIP CONNECTORS. PROVIDE DIAGONAL BRACING FIXED TO TOP CHORDS AT A MAX ANGLE OF 30° TO RIDGE. ANCHOR STRAP BRACING WITH 6 No 30x1.5 NAILS INTO DOUBLE TOP PLATE. WIND BRACING TO COMPLY WITH NCC

CAPPINGS & FLASHINGS


ALLOW FOR PREFORMED CAPPINGS & FLASHINGS NECESSARY TO ENSURE THE INTEGRITY OF THE ROOF STRUCTURE AGAINST WATER PENETRATION, INSTALL FLASHINGS TO ROOF VENTS, FLUES ETC. ALTERNATIVELY USE "DEKTITE" OR SIMILAR FITTINGS TO ROOF PENETRATIONS


INSTALL SELECTED COLORBOND QUAD GUTTERS OR AS NOMINATED BY THE OWNER, LAP GUTTERS 75MM IN THE DIRECTION OF FLOW, RIVET & SEAL WITH AN APPROVED SILICONE SEALANT. VALLEY GUTTERS TO BE 450 WIDE COLORBOND STEEL TO MATCH ROOF. LAP 150MM UNDER ROOF CLADDING AND TURN UP ON BOTH SIDES. LAP 150MM IN DIRECTION OF FLOW

DOWNPIPES

DOWNPIPES TO BE DN90 PVC PAINTED TO MATCH GUTTERING. FIX WITH WALL BRACKETS @ 1200CC BEGINNING AT DOWNPIPE ELBOW. MAXIMUM CENTRES FOR GUTTERS TO BE 12000



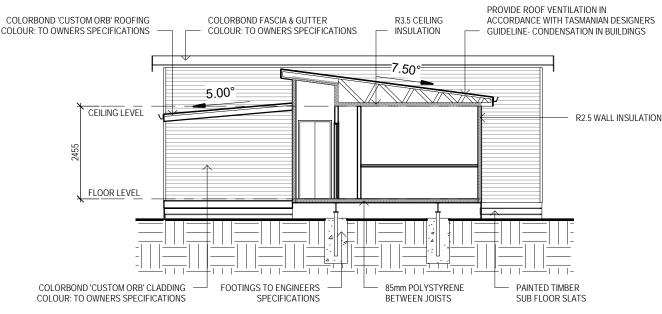

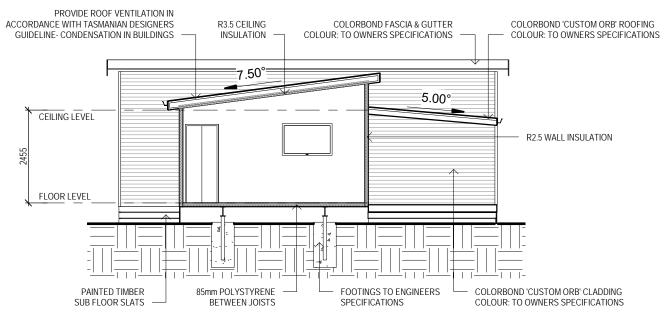

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Date Drawn: 10.04.24 Drawn: O. Jones Checked: O. Jones Approved: J. Pfeiffer Scale: As Shown @ A3 | trin@engineeringplus.com.au Accredited Building Designer

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Rev: Amendment:

11.04.24 O.J Designer Name: J.Pfeiffer

Date: Int: Accreditation No: CC2211T

Mob 0417 362 783 or 0417 545 813 **ENGINEERING**

PLUS PROJECT MANAGEMENT CIVIL/STRUCTURAL ENG

EUGENANA

Project: PROPOSED DWELLING

Address: 363 MELROSE ROAD,

Rev

Drawing No:


1132024 A07 / A08





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PLUS MELAGORI EROAD,
PLUS MELAGORI

Drawing No:

Accredited Building Designer

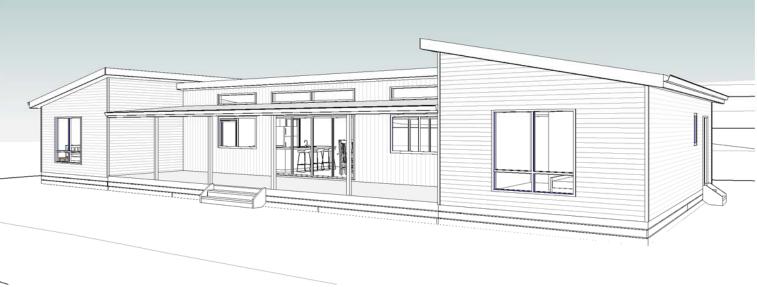11.04.24 O.J
Date: Int: Accreditation No: CC2211T
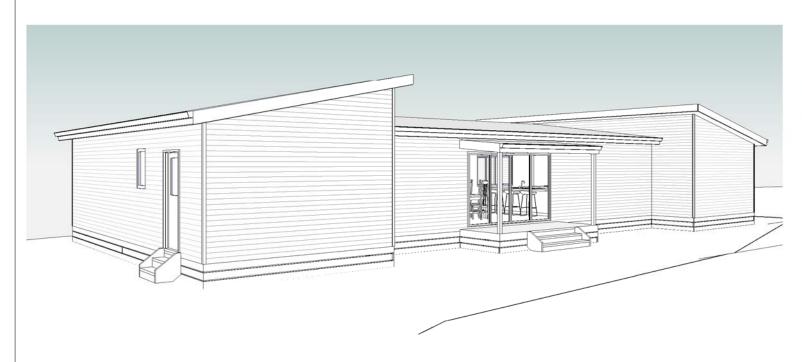
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Rev: Amendment:
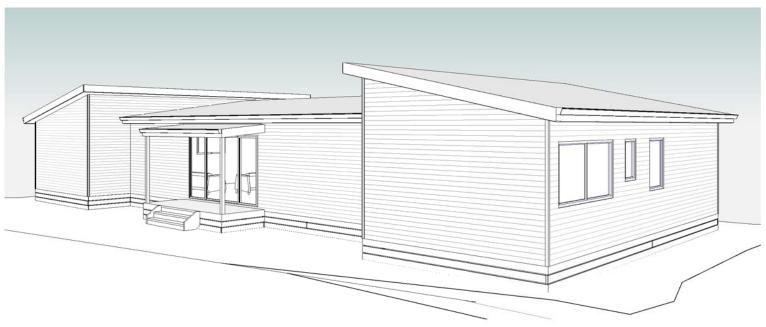
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